


HALF SECTION IN EARTH EXCAVATION  
HALF SECTION IN ROCK EXCAVATION  
**TYPICAL SECTION**

**TRENCH WIDTHS**





PIPE SIZE	TRENCH WIDTH "B" MIN.	TRENCH WIDTH "B" MAX.
4"	24"	30"
6"	24"	30"
8"	24"	36"
10"	26"	36"
12"	28"	40"
14"	30"	42"
16"	30"	42"
18"	32"	42"
24"	42"	60"
30"	50"	62"
36"	56"	68"

**NOTES:**

- TRENCH WIDTH "B" IS MEASURED AT A POINT 12" ABOVE TOP OF PIPE. TRENCH WIDTH AT 12" ABOVE TOP OF PIPE CAN NOT EXCEED "B" MAX. TRENCH WIDTH ABOVE THIS POINT CAN EXCEED "B" MAX.
- TRENCH WIDTH REQUIRED FOR STEEL TRENCH BOXES IN EXCESS OF THE MAXIMUM WIDTHS INDICATED ABOVE WILL BE SUBJECT TO THE APPROVAL OF THE ENGINEER.
- IF THE EXCAVATED NATIVE MATERIAL IS JUDGED TO BE UNSUITABLE FOR BACKFILL BY THE ENGINEER, IT WILL BE REMOVED FROM THE SITE BY THE CONTRACTOR AND REPLACED WITH SELECT FILL.
- IN UNSTABLE TRENCHES PROVIDE SUFFICIENT 1/2" CRUSHED STONE TO WITHIN 8" OF THE BOTTOM OF PIPE TO PREPARE A FIRM BASE FOR THE 3/8" CRUSHED STONE BEDDING. IF REQUIRED BY THE ENGINEER EXTEND THE 3/8" CRUSHED STONE COMPACTED IN PLACE TO 12" ABOVE THE TOP OF PIPE.
- BASE AND SURFACE COURSE PAVEMENT SHALL BE CONSTRUCTED IN ACCORDANCE WITH BOROUGH REQUIREMENTS.

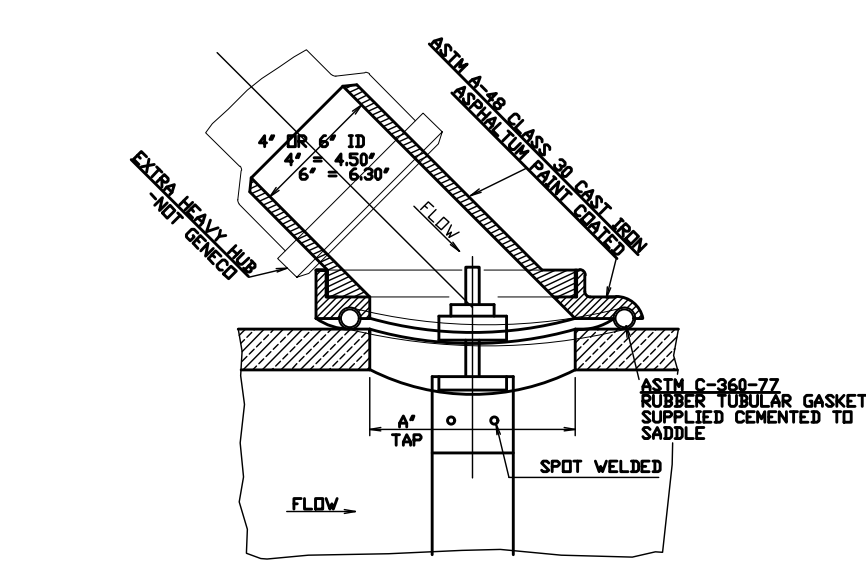

**SANITARY SEWER WYE SADDLE CONNECTION**  
NO SCALE

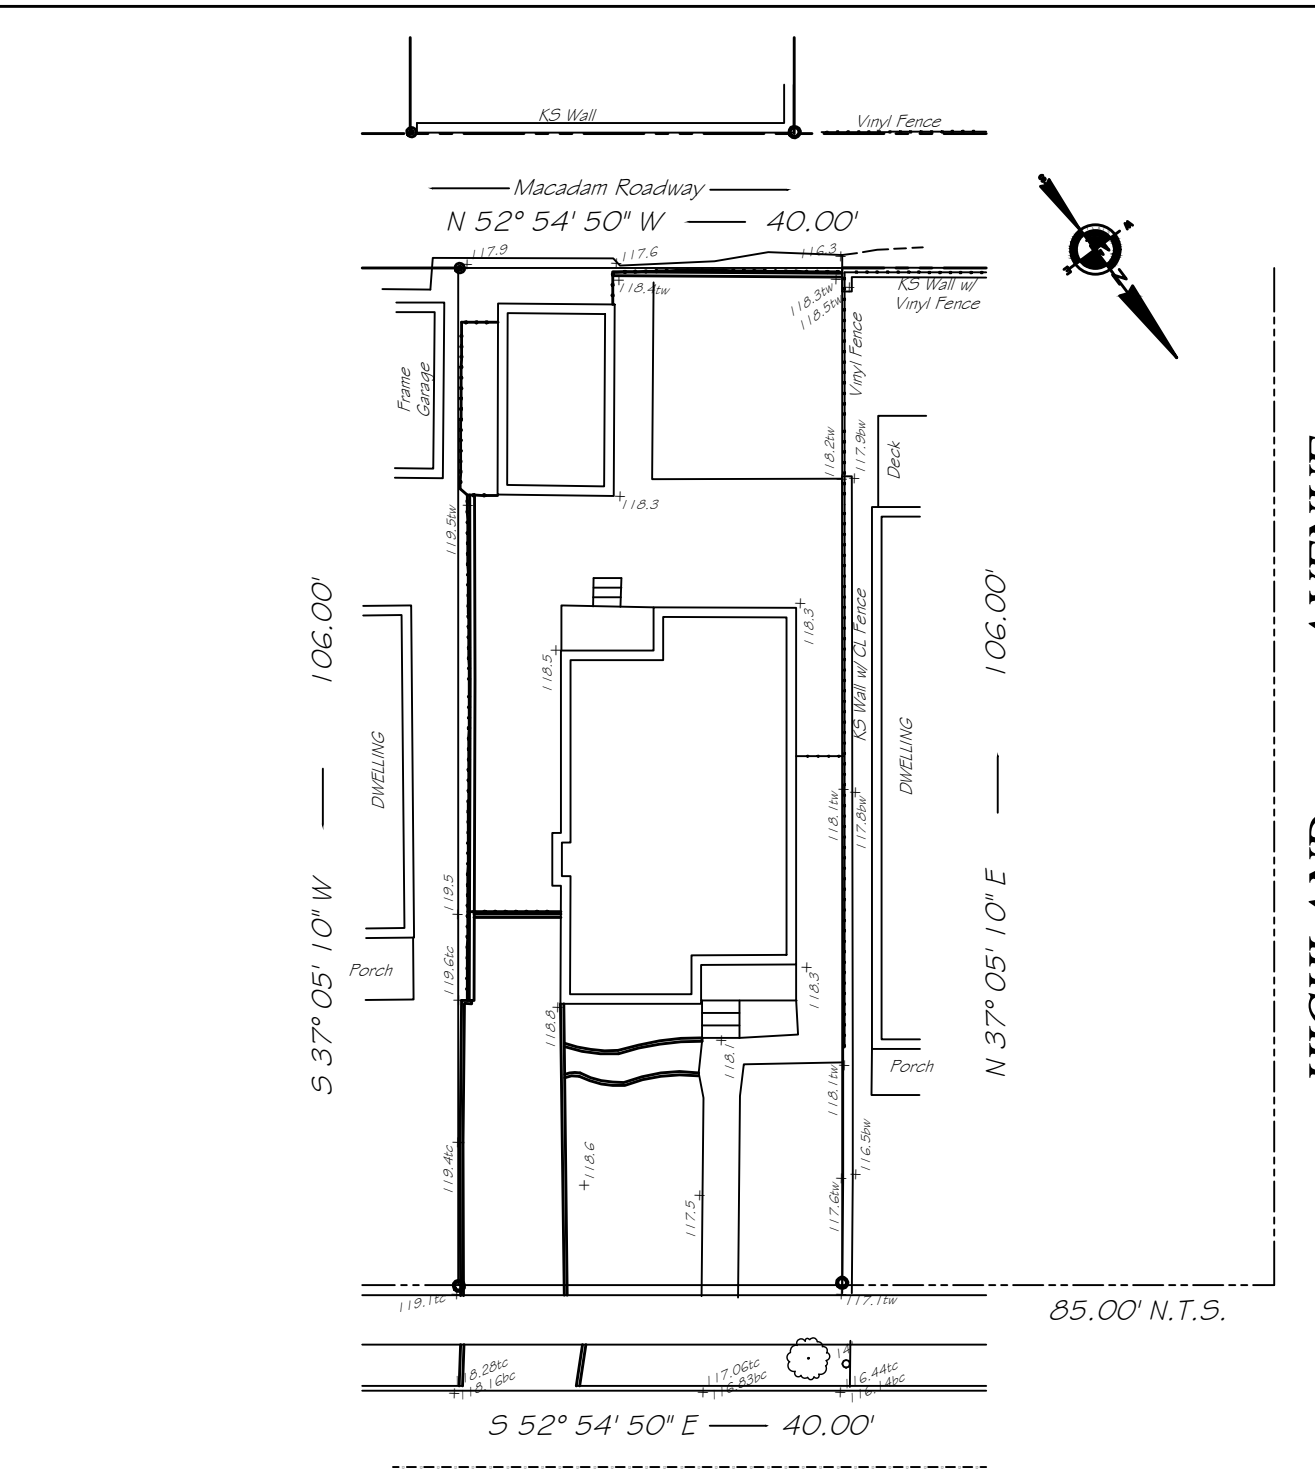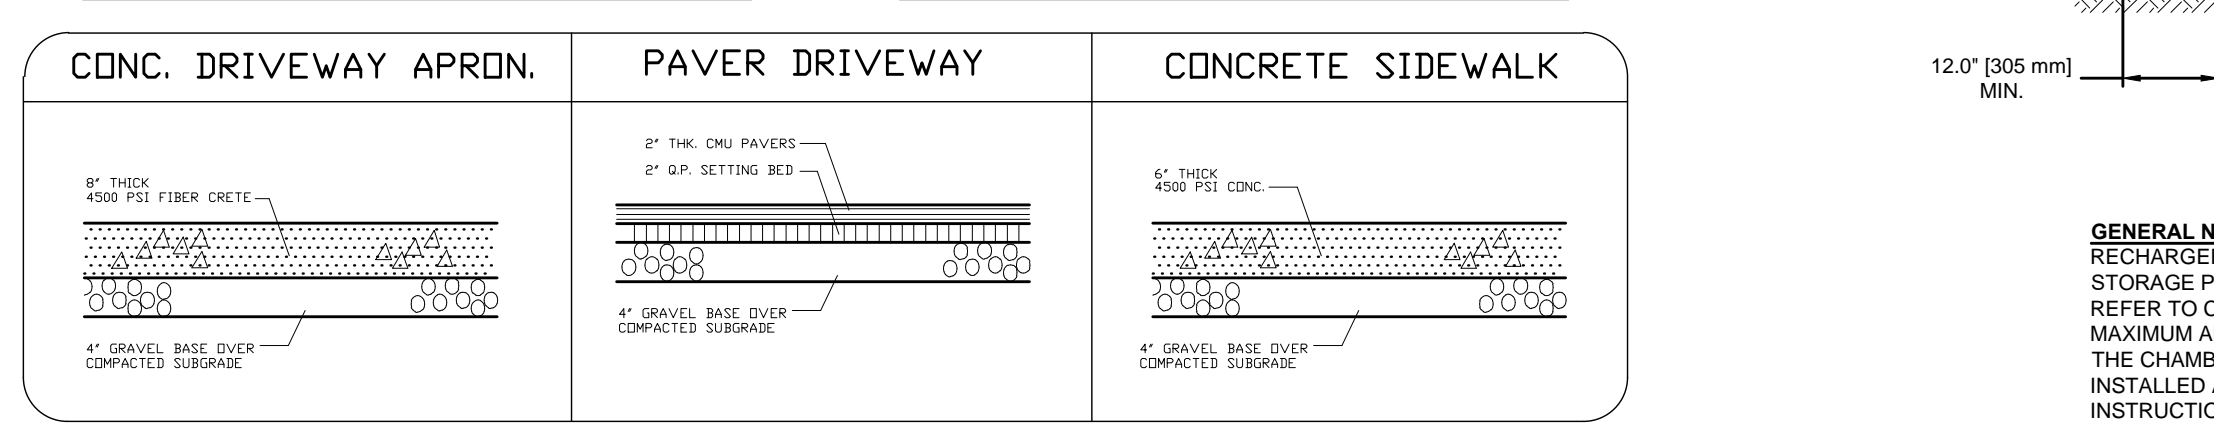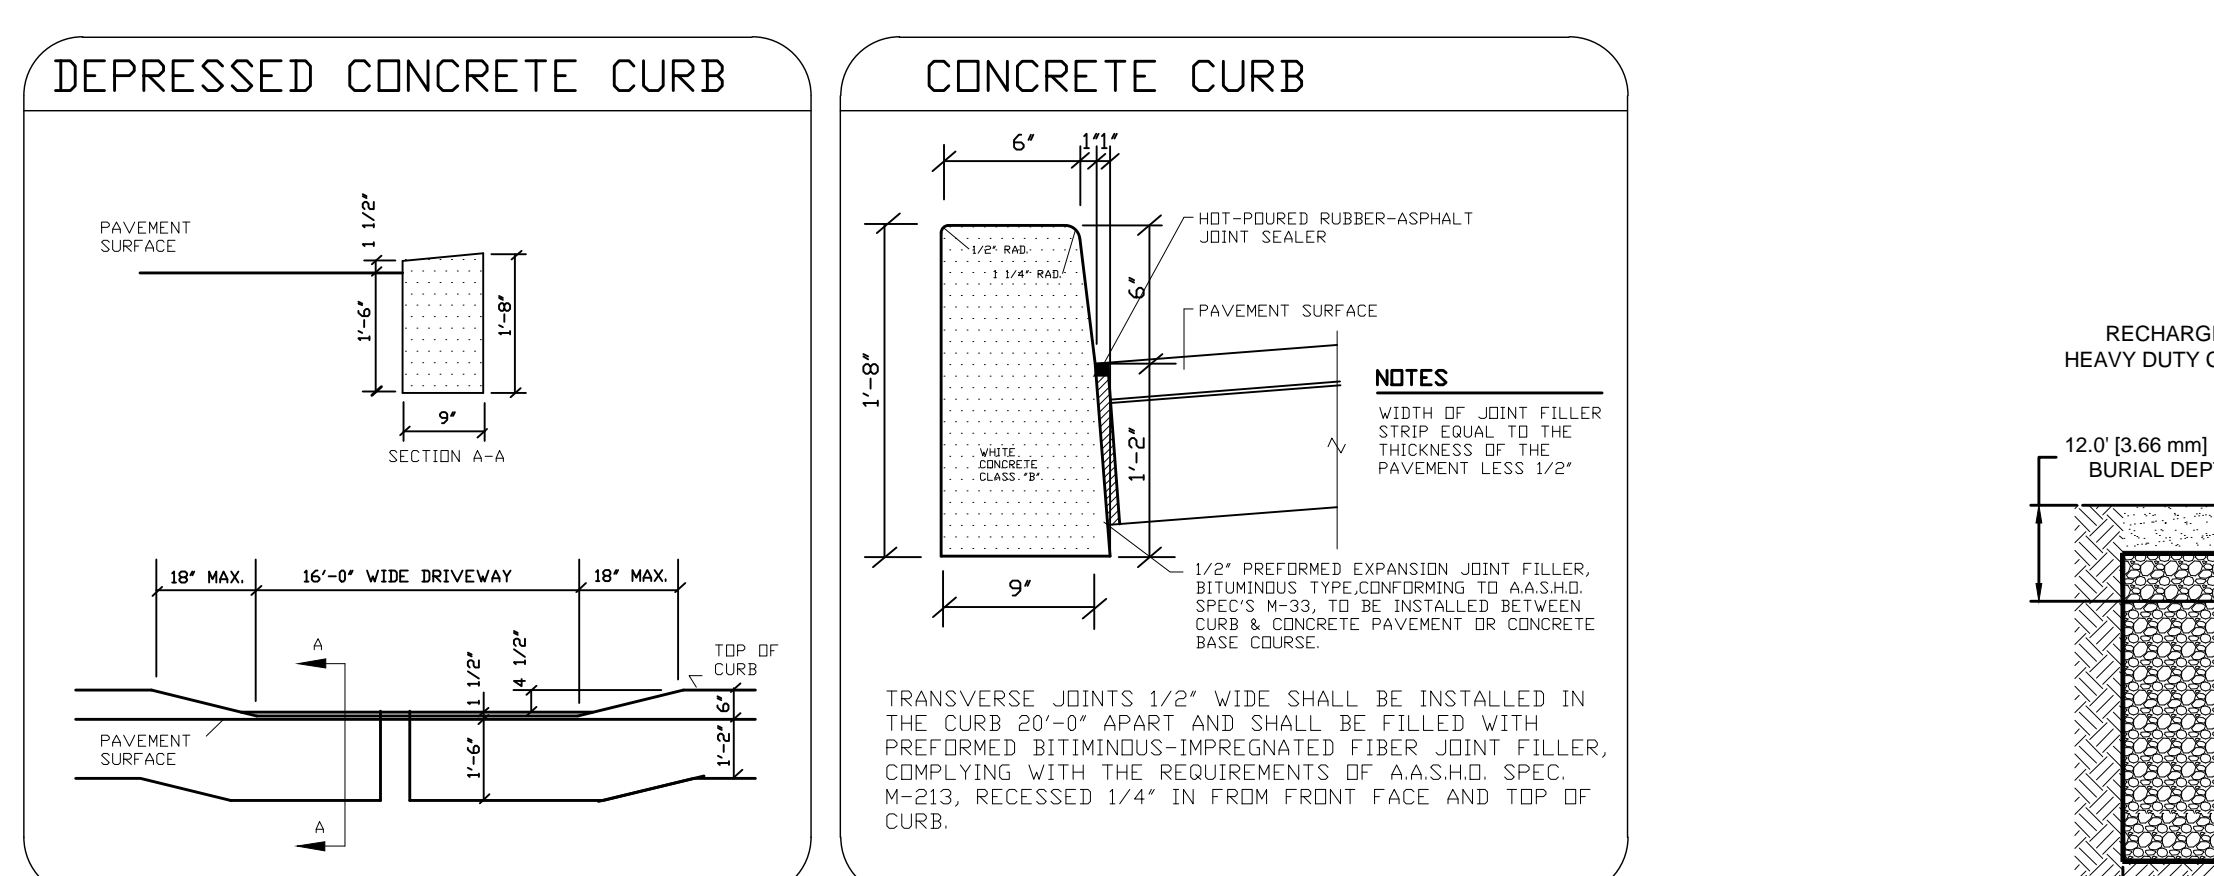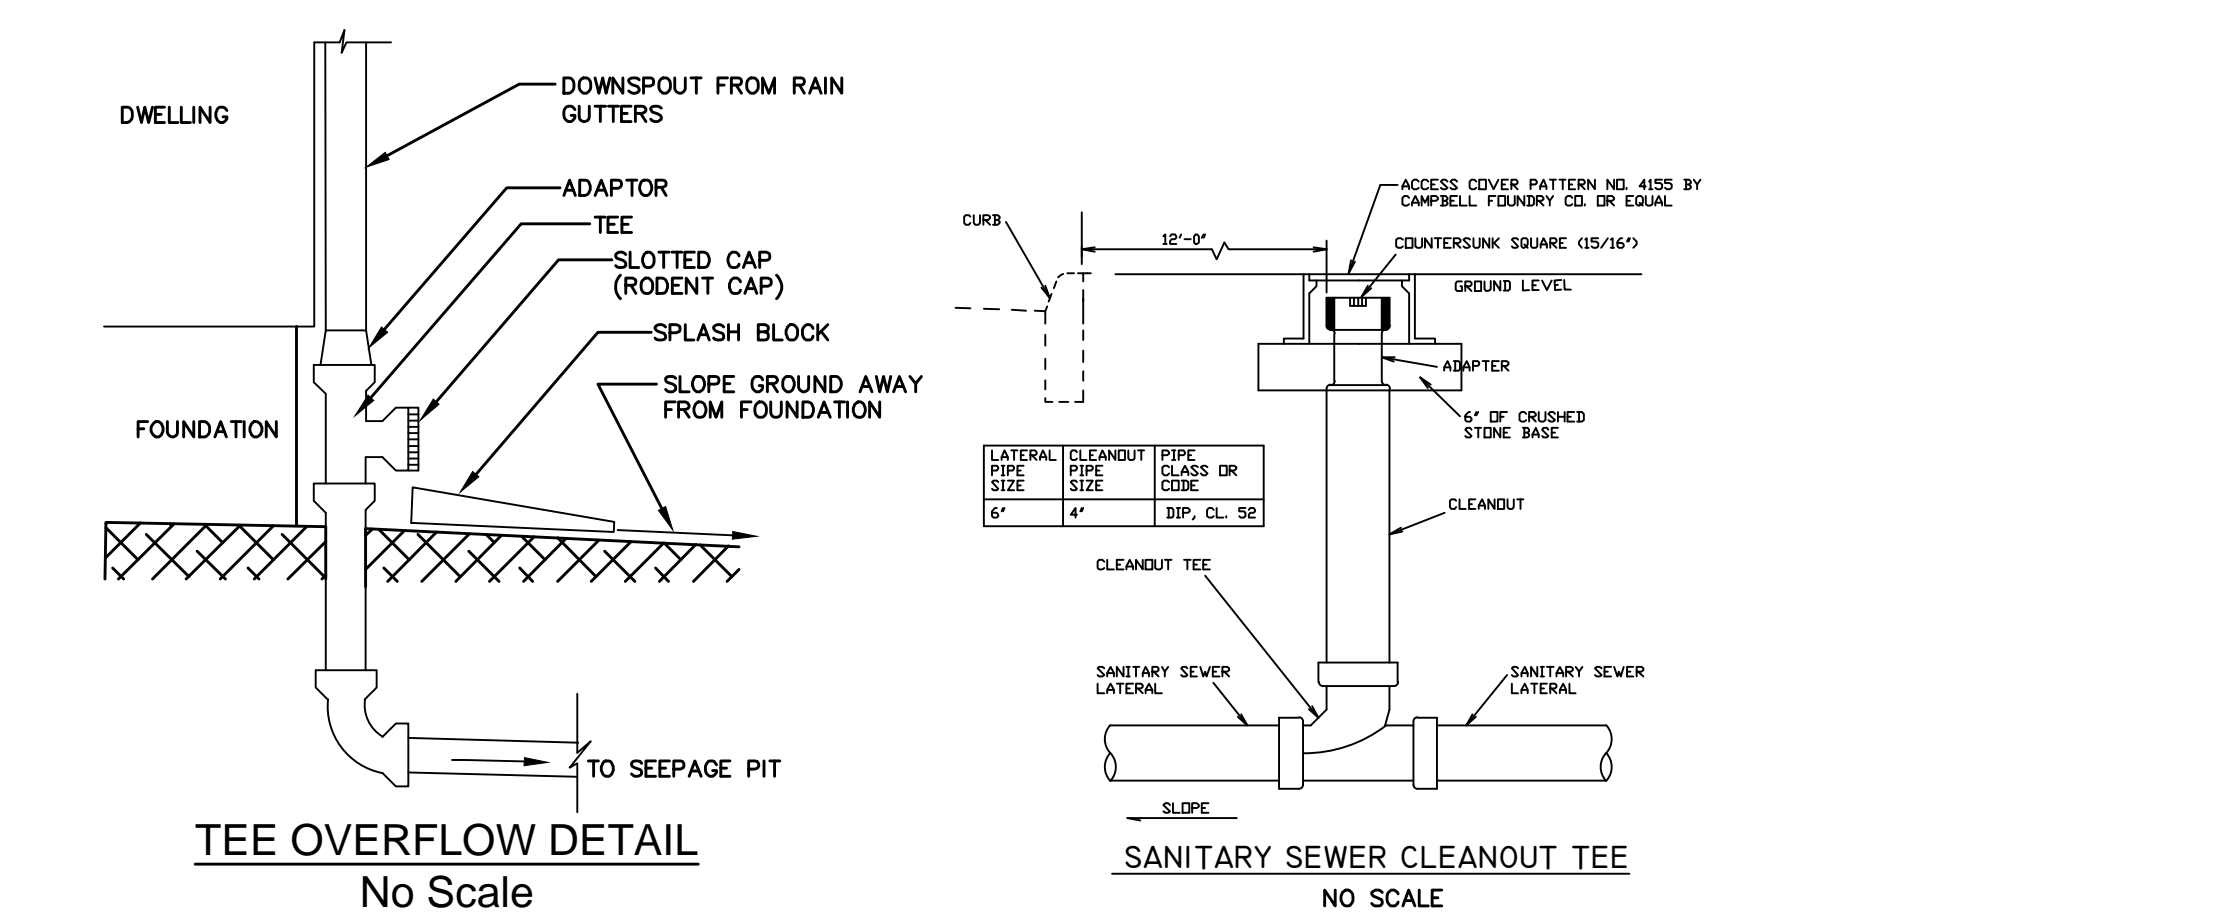


**BRINKERHOFF 66' WIDE TERR.**  
**EXISTING SITE SCALE: 1" = 20'-0"**

36 BRINKERHOFF AVE, PALISADES PARK, NEW JERSEY  
BLOCK: 214 LOT: 3 ZONING INFO - AA ZONE

CATEGORY:	REQUIRED	PROPOSED	VARIANCE
LOT SIZE (EXISTING):	5,000 SQUARE FEET	4,240 SQUARE FEET	YES (1)
LOT WIDTH (EXISTING):	50.00 FEET	40.00 FEET	YES (1)
LOT DEPTH (EXISTING):	100.00 FEET	106.00 FEET	NO
DWELLING UNITS:	TWO	TWO (2)	NO
LOT AREA PER UNIT:	2,500 SQUARE FEET	2,120 SQUARE FEET	YES
BUILDING COVERAGE:	2,500 SQ. FEET MAX 40.00%	1,881 SQ. FEET 42.55 %	NO YES
FRONT YARD: (2)	24.00 FEET (2)	24.00 FEET	NO
RIGHT SIDE YARD (3)	5.00 FEET	3.50 FEET	YES
LEFT SIDE YARD (3)	5.00 FEET	3.50 FEET	YES
COMBINED YARD (3)	14.00 FEET	7.50 FEET	YES
REAR YARD:	25.00 FEET	25.00 FEET	NO
BUILDING HEIGHT: (3)	2.5 STORIES 25.00 FEET	3.0 STORIES 28.92 FEET	YES

- PRE-EXISTING NON-COMFORMING CONDITION
- BASED ON PREVAILING SETBACK ALONG BRINKERHOFF AVENUE
- NON DUPLICATION REQUIREMENTS

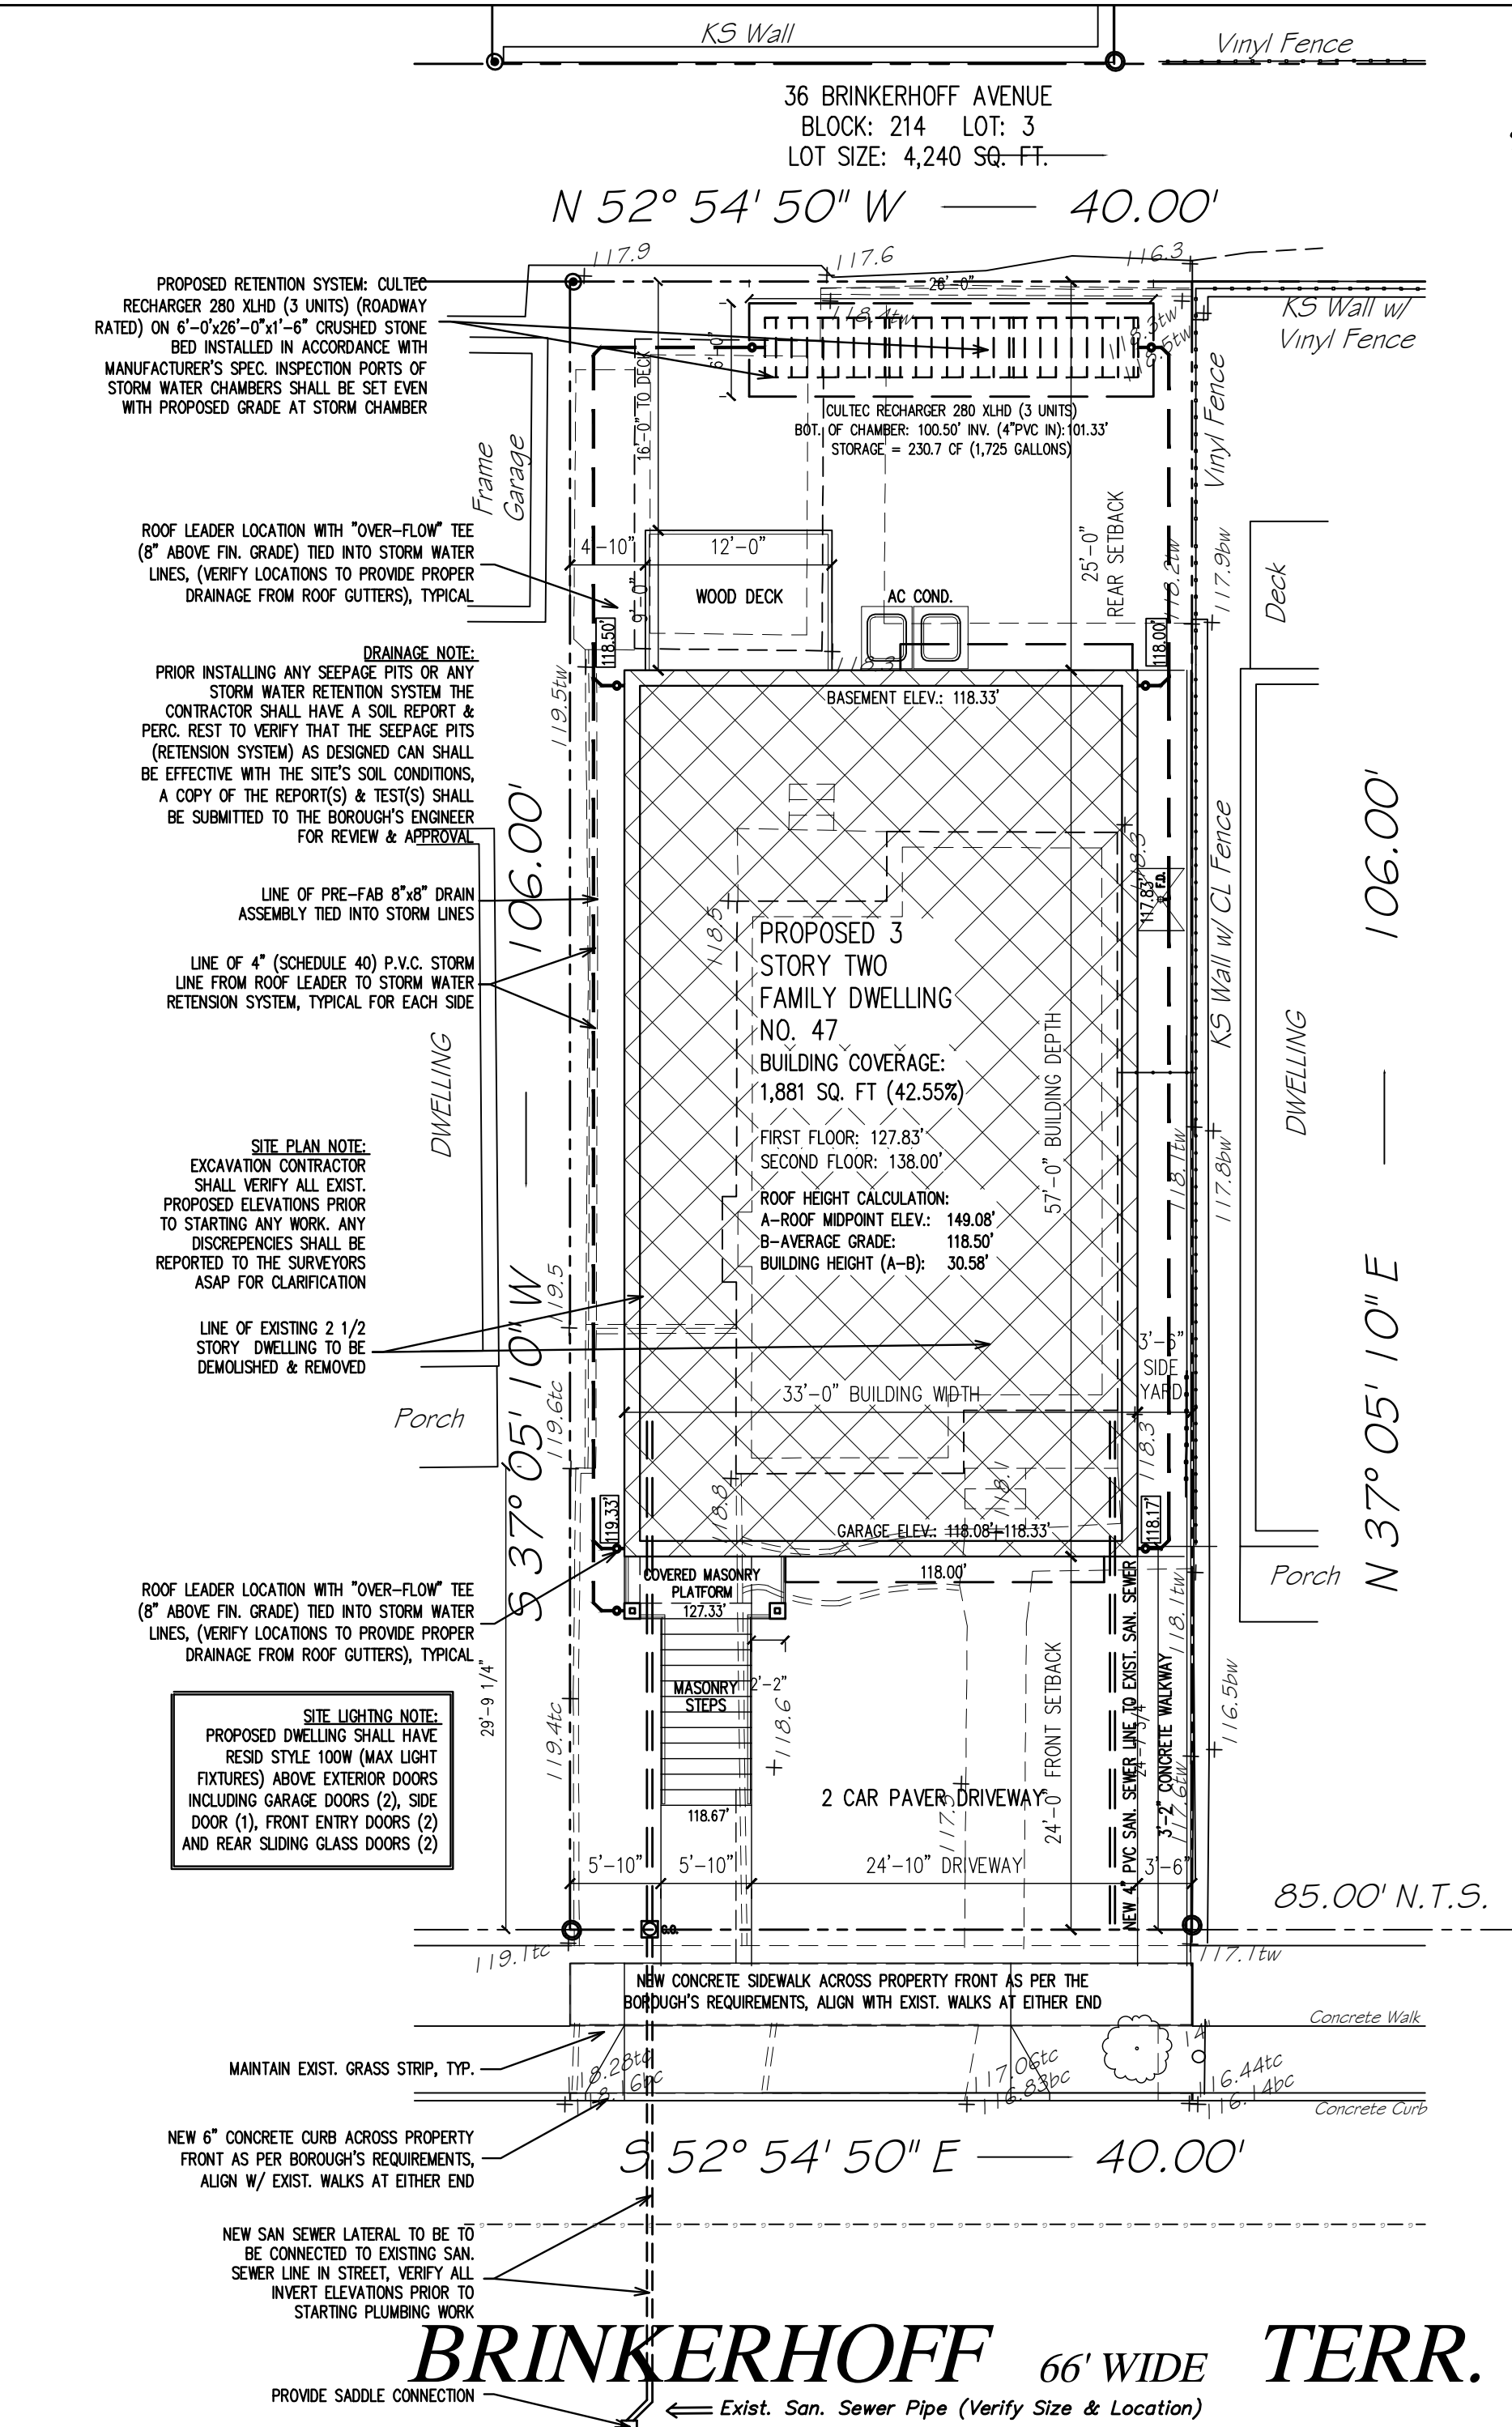

**BRINKERHOFF 66' WIDE TERR.**  
**SCHEMATIC SITE PLAN SCALE: 1" = 10'-0"**

**CULTEC RECHARGER 280HD MAINTENANCE SCHEDULE**

Inlets and Outlets	Frequency	Action
Inlets and Outlets	Every 3 years	Obtain documentation that the inlets, outlets and vents have been cleaned and will function as intended.
Inlets and Outlets	Spring and Fall	Check inlet and outlets for clogging and remove any debris as required.
CULTEC Stormwater Chambers	2 years after commissioning	Inspect the interior of the stormwater management chambers through inspection port for deficiencies using CCTV or comparable technique.
CULTEC Stormwater Chambers	9 years after commissioning every 9 years following	Obtain documentation that the stormwater management chambers and feed connectors will function as anticipated.
CULTEC Stormwater Chambers	9 years after commissioning every 9 years following	Clean stormwater management chambers and feed connectors of any debris.
CULTEC Stormwater Chambers	9 years after commissioning every 9 years following	Inspect the interior of the stormwater management structures for deficiencies using CCTV or comparable technique.
CULTEC Stormwater Chambers	45 years after commissioning	Obtain documentation that the stormwater management chambers and feed connectors have been cleaned and will function as intended.
CULTEC Stormwater Chambers	45 years after commissioning	Clean stormwater management chambers and feed connectors of any debris.
CULTEC Stormwater Chambers	45 years after commissioning	Determine the remaining life expectancy of the stormwater management chambers and recommended schedule and actions to rehabilitate the stormwater management chambers as required.
CULTEC Stormwater Chambers	45 years after commissioning	Inspect the interior of the stormwater management chambers for deficiencies using CCTV or comparable technique.
CULTEC Stormwater Chambers	Yearly	Replace or restore the stormwater management chambers in accordance with the schedule determined at the 45-year inspection.
CULTEC Stormwater Chambers	Yearly	Confirm that no unauthorized modifications have been performed to the site.
Surrounding Site	Monthly in 1 <sup>st</sup> year	Check for depressions in areas over and surrounding the stormwater management system.
Surrounding Site	Spring and Fall	Check for depressions in areas over and surrounding the stormwater management system.
Surrounding Site	Yearly	Confirm that no unauthorized modifications have been performed to the site.

For additional information concerning the maintenance of CULTEC Subsurface Stormwater Management Chambers, please contact CULTEC, Inc. at 1-800-428-5832.

**V.C.A. GROUP**  
VASSILIOS COCOROS ARCHITECT

V.C.A.GROUP, LLC  
467 SYLVAN AVENUE  
LOWER LEVEL  
ENGLEWOOD CLIFFS, NEW JERSEY  
TEL. 201.541.6595  
FAX. 201.541.6596

- NOTES:**
- PROPERTY DESCRIPTION:  
47 HENRY STREET  
PALISADES PARK, N.J.  
TAX MAP BLOCK: 214 LOT: 21
  - ALL CONSTRUCTION WORK MUST BE PERFORMED IN ACCORDANCE WITH ALL APPLICABLE RULES AND REGULATIONS OF THE OCCUPATIONAL SAFETY AND HEALTH ADMINISTRATION (OSHA), THE NEW JERSEY UNIFORM CONSTRUCTION CODE, FEDERAL, STATE, AND LOCAL REQUIREMENTS, MANUFACTURER'S INSTALLATION REQUIREMENTS AND PROCEDURES, AND GOOD CONSTRUCTION AND ENGINEERING PRACTICE AS PERTAINS TO SAFETY.
  - CURBS, DRIVEWAYS, SIDEWALKS AND STORM SEWERS SHALL BE CONSTRUCTED TO BOROUGH SPECIFICATIONS.
  - ANY ADJACENT STRUCTURES, RETAINING WALLS, LANDSCAPING, CURBS, PIPING, PAVEMENT, FENCES, ETC. DAMAGED DURING CONSTRUCTION MUST BE REPAIRED OR REPLACED.
  - ALL ROOF LEADERS SHALL BE CONNECTED INTO SEEPAGE PITS.
  - BEFORE CONSTRUCTION CONTRACTOR SHALL VERIFY THE LOCATION AND DEPTHS OF ALL UTILITIES AND SHALL IMMEDIATELY NOTIFY THE ENGINEER OF ANY CONFLICTS W/ THIS PLAN.

Architect shall not be responsible for the means & methods of construction and or site maintenance & safety

**PROJECT:**  
Proposed:  
**New Two Family Dwelling**  
Located at:  
**36 Brinkerhoff Avenue**  
**Palisades Park, New Jersey**  
**Block: 214 Lot: 3**  
**AA Residential Zone**

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Date	Item
12/04/20	BOARD REVIEW

**DRAWING TITLE:**  
**STORMWATER PLAN & DETAILS**

SCALE: AS NOTED DATE: 11/20/20  
DESIGNED BY: VC PROJECT#: J8a-20-06  
DRAWN BY: VC CAD FILE:  
CHECKED BY: VC DRAWING #:  
PROFESSIONAL SEAL: DRAWING:  
S1  
VASSILIOS COCOROS, RA  
N.J. LIC. # A13644 SHEET #: 1 OF 2